


## **CONSTRUCTION NOTES:**

DIMENSIONS SHOWN ARE APPROXIMATE. COORDINATE LOCATION OF IMPROVEMENTS WITH OWNER'S

2. CONTRACTOR IS RESPONSIBLE FOR OBTAINING UTILITY LOCATES PRIOR TO CONSTRUCTION. EXERCISE CAUTION DURING CONSTRUCTION AND AVOID CONTACT WITH UTILITIES ABOVE AND BELOW GRADE. PROTECT AND MAINTAIN SERVICE OF EXISTING UTILITIES DURING CONSTRUCTION.

- 3. ALL WORK WITHIN ALASKA RAILROAD RIGHT-OF-WAY MUST BE COORDINATED WITH OWNER'S REPRESENTATIVE, DAVE RIZK, PH: 907-265-4406. SEVEN (7) DAY ADVANCE NOTICE IS REQUIRED BEFORE MOBILIZING TO ALASKA RAILROAD JOB SITE.
- 4. COMPLY WITH ALASKA RAILROAD ON-TRACK SAFETY PROCEDURES AND AVOID FOULING TRACK EXCEPT WHEN NECESSARY TO PERFORM DUTIES AND ONLY WHEN FLAG PROTECTION IS PROVIDED. A TRACK IS CONSIDERED FOULED WHEN WORKER OR EQUIPMENT IS WITHIN 20 FEET OF THE NEAREST RAIL. REFER TO SECTION 21.2.1, ALASKA RAILROAD ROADWAY WORKER PROTECTION, ON-TRACK SAFETY GUIDE.
- 5. RAILROAD FLAG PROTECTION IS REQUIRED FOR THIS WORK AND WILL BE PROVIDED ON A PRE-APPROVED, SCHEDULED BASIS AT NO COST TO CONTRACTOR.



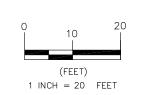


RAILROAD CORPORATION ENGINEERING SERVICES ALASKA P.O. BOX 107500, ANCHORAGE, ALASKA 99510-7500

**SIGNAL MP 395.16 - ANDERSON CROSSING** 

SITE PLAN **GRAVEL PAD EXPANSION** 

DESIGNED BY: SCALE : AS NOTED DRAWN BY: CHECKED BY: DJR DATE : DECEMBER 2021 APPROVED BY: DJR

ACAD FILE: DWG NO. 1 OF 2

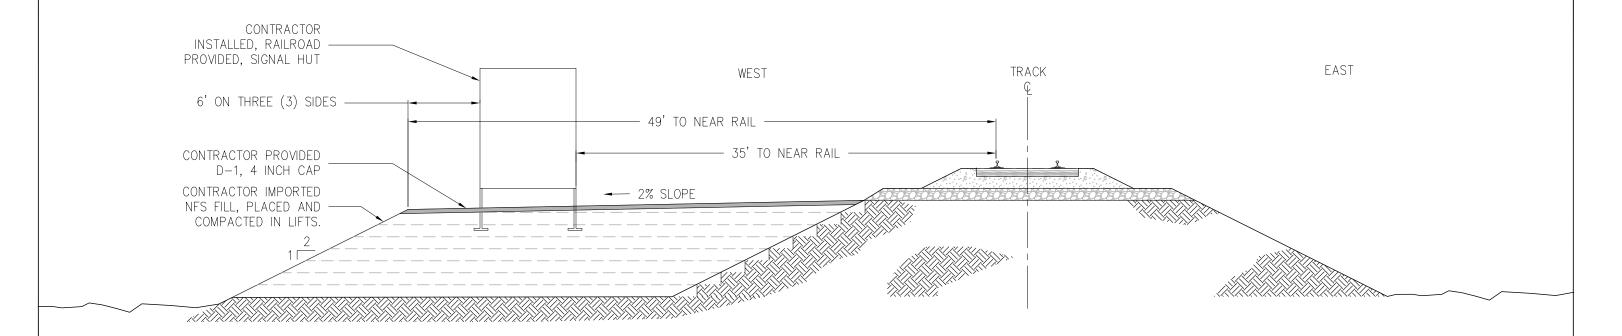



## **CONSTRUCTION NOTES:**

- 1. REMOVE VEGETATION AND TOP FOUR (4) INCHES OF SOIL WITHIN FILL FOOTPRINT. DISPOSE OF MATERIALS REMOVED IN RAILROAD RIGHT-OF-WAY AS DIRECTED BY OWNER'S REPRESENTATIVE.
- 2. WET AND COMPACT EACH LIFT.
- 3. CONTRACTOR IS REQUIRED TO SUBMIT COMPACTION METHOD, INCLUDING EQUIPMENT SPECIFICATIONS AND LIFT SIZE, FOR REVIEW AND APPROVAL BY ALASKA RAILROAD ENGINEER PRIOR TO START OF WORK. DESIRED COMPACTION IS 95% OF STANDARD PROCTOR.
- 4. APPROXIMATE NON-FROST SUSCEPTIBLE (NFS) FILL VOLUME: 490 CUBIC YARDS.
- 5. APPROXIMATE D-1 CAP VOLUME: 13 CUBIC YARDS.
- 6. CONTRACTOR IS RESPONSIBLE FOR INSTALLING PROVIDED SIGNAL HUT IN LOCATION SHOWN PER INSTRUCTIONS PROVIDED IN ENGINEERING SIGNAL PACKAGE.



ALASKA RAILROAD CORPORATION ENGINEERING SERVICES

P.O. BOX 107500, ANCHORAGE, ALASKA 99510-7500

SIGNAL
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SECTION
GRAVEL PAD EXPANSION

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